






EXISTING FRONT ELEVATION
SCALE 1:100

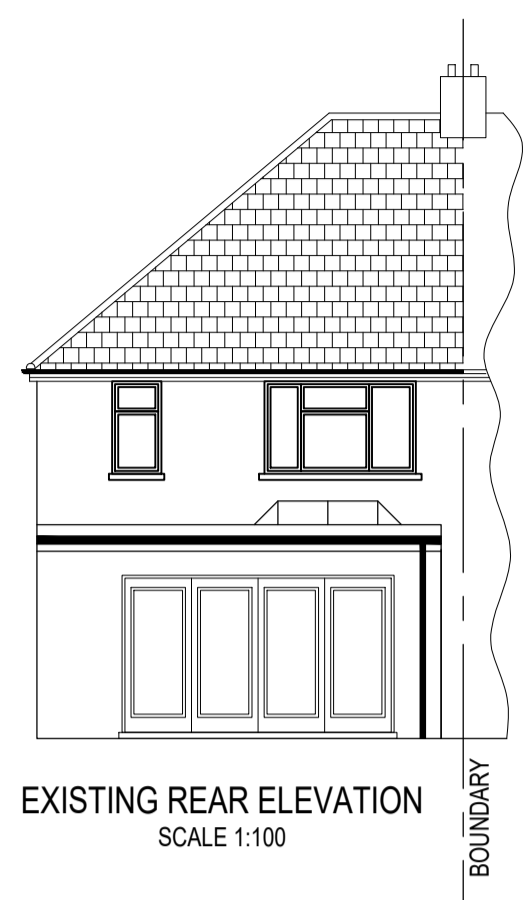

EXISTING REAR ELEVATION
SCALE 1:100

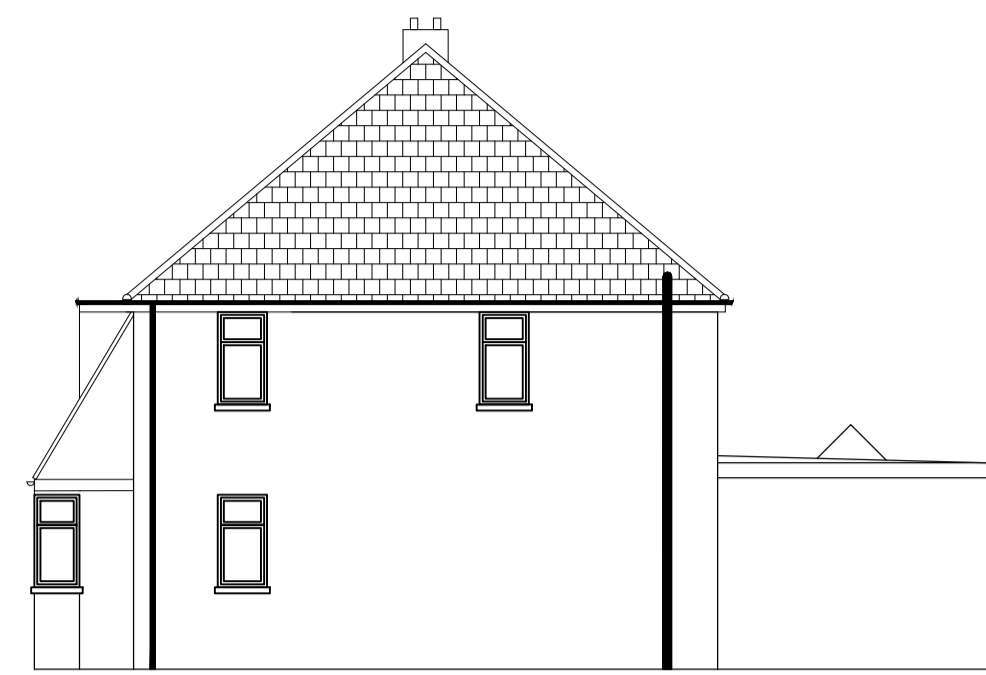


EXISTING SIDE ELEVATION
SCALE 1:100

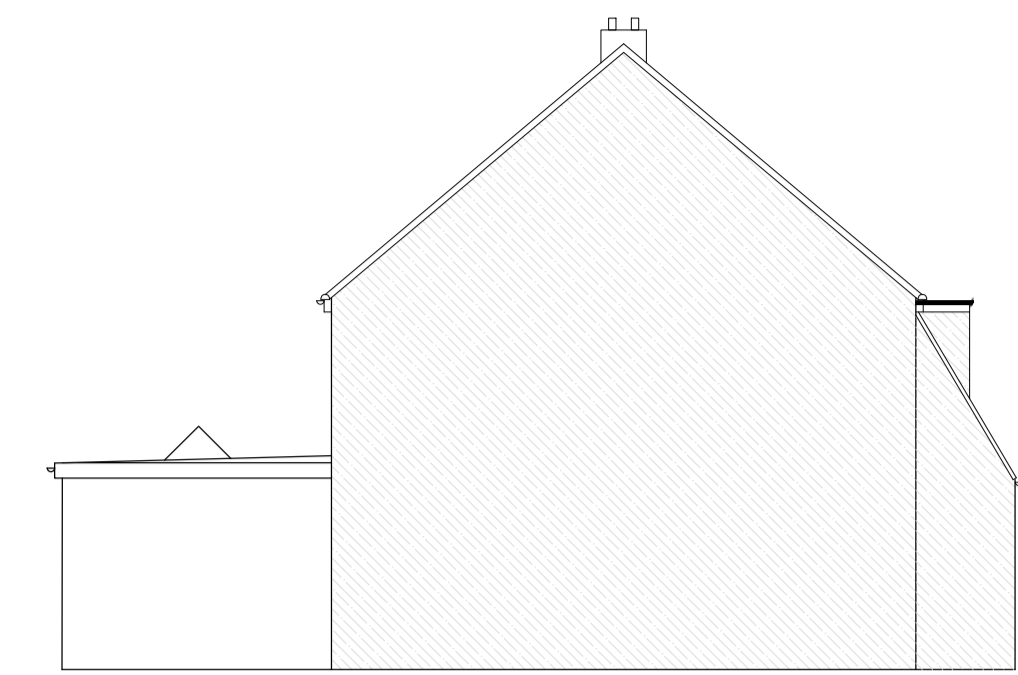


EXISTING SIDE ELEVATION
SCALE 1:100




LOCATION PLAN
SCALE 1:1250

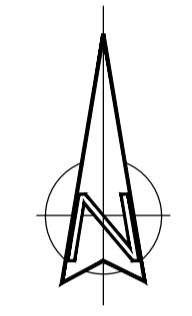


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 3. DO NOT SCALE THIS DRAWING.

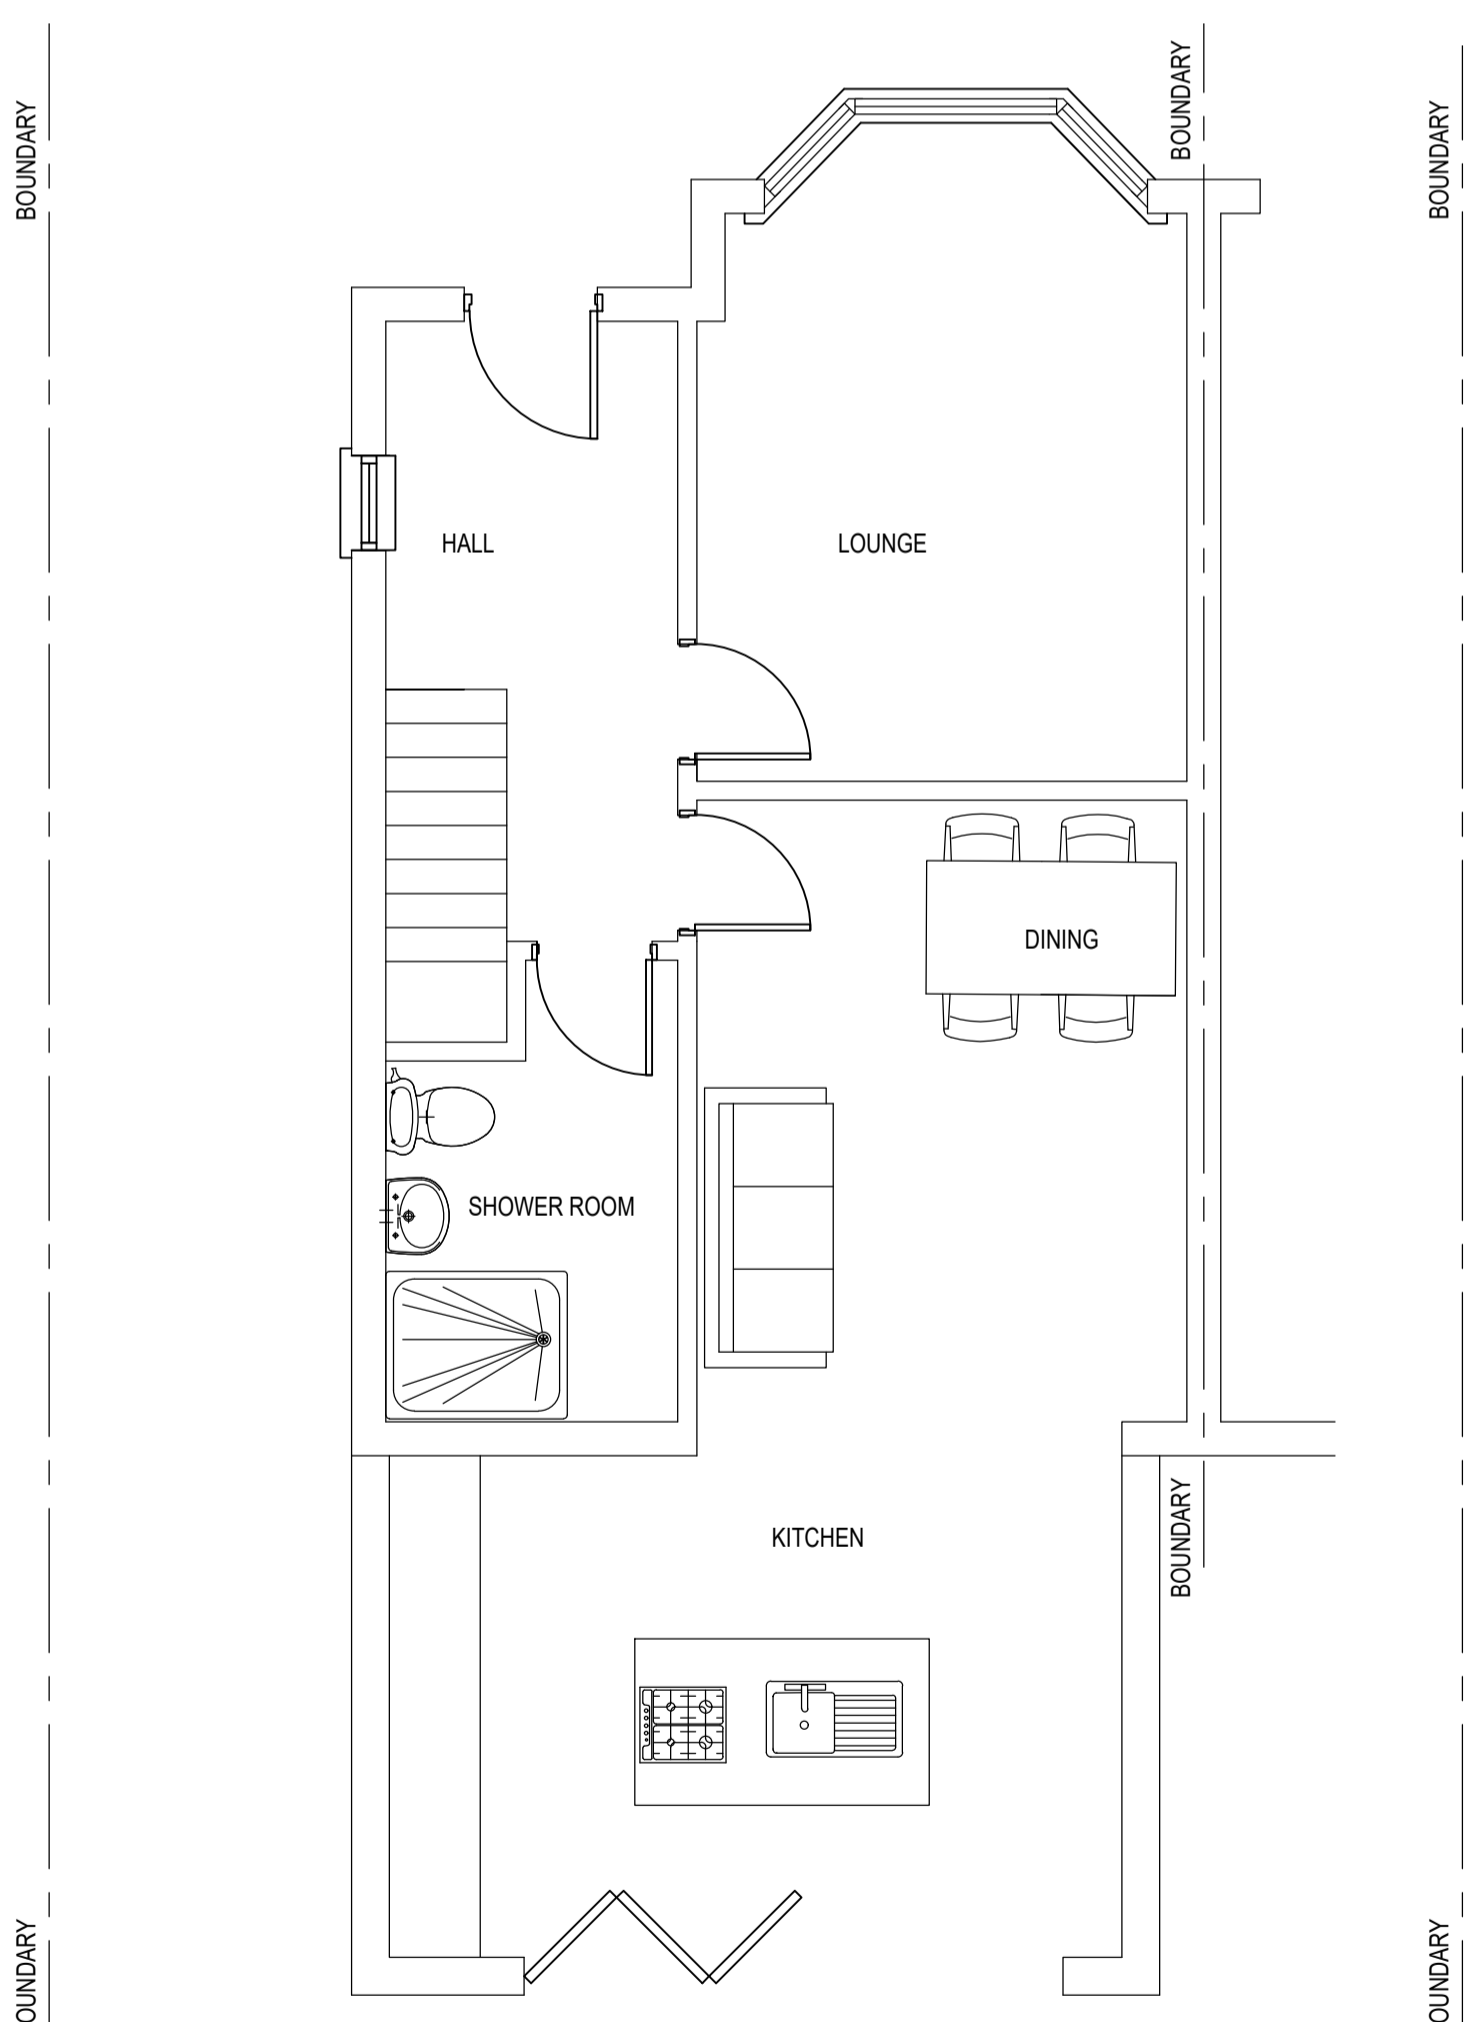



EXISTING GROUND FLOOR PLAN
SCALE 1:50

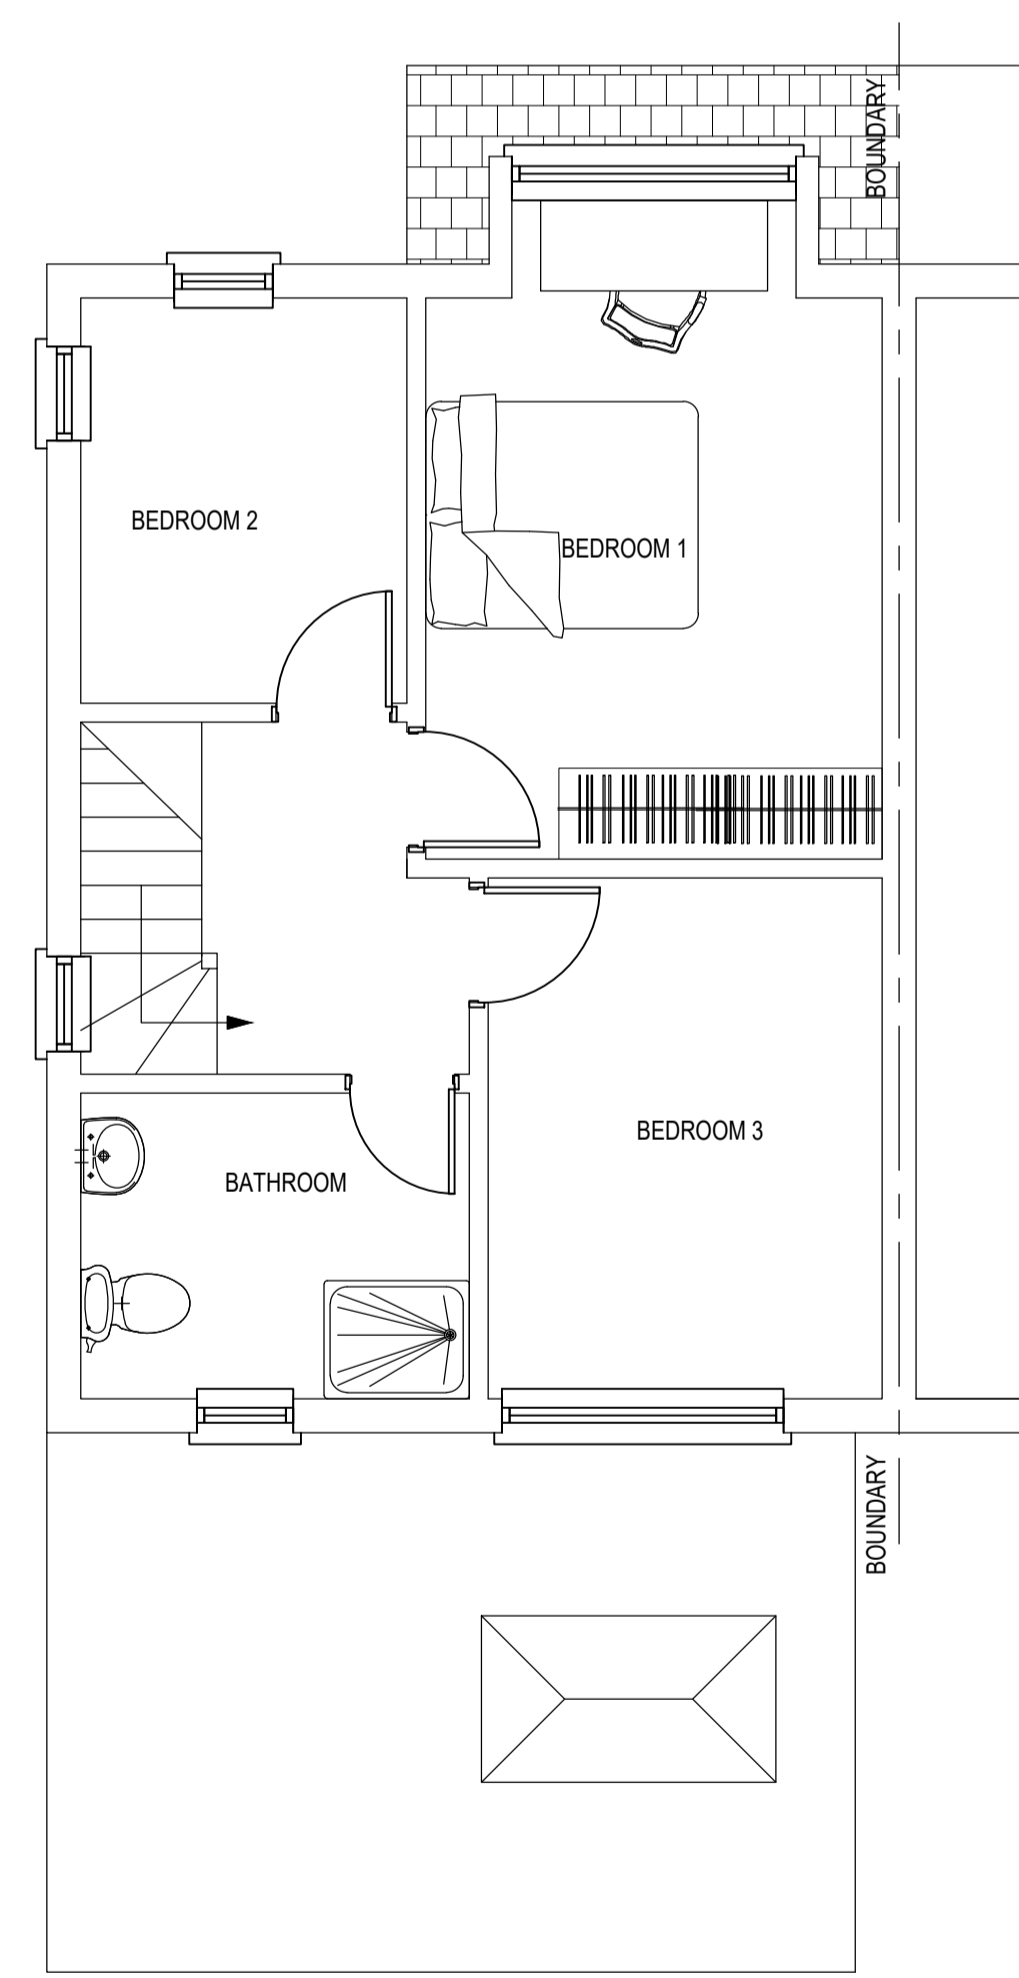

EXISTING FIRST FLOOR PLAN
SCALE 1:50

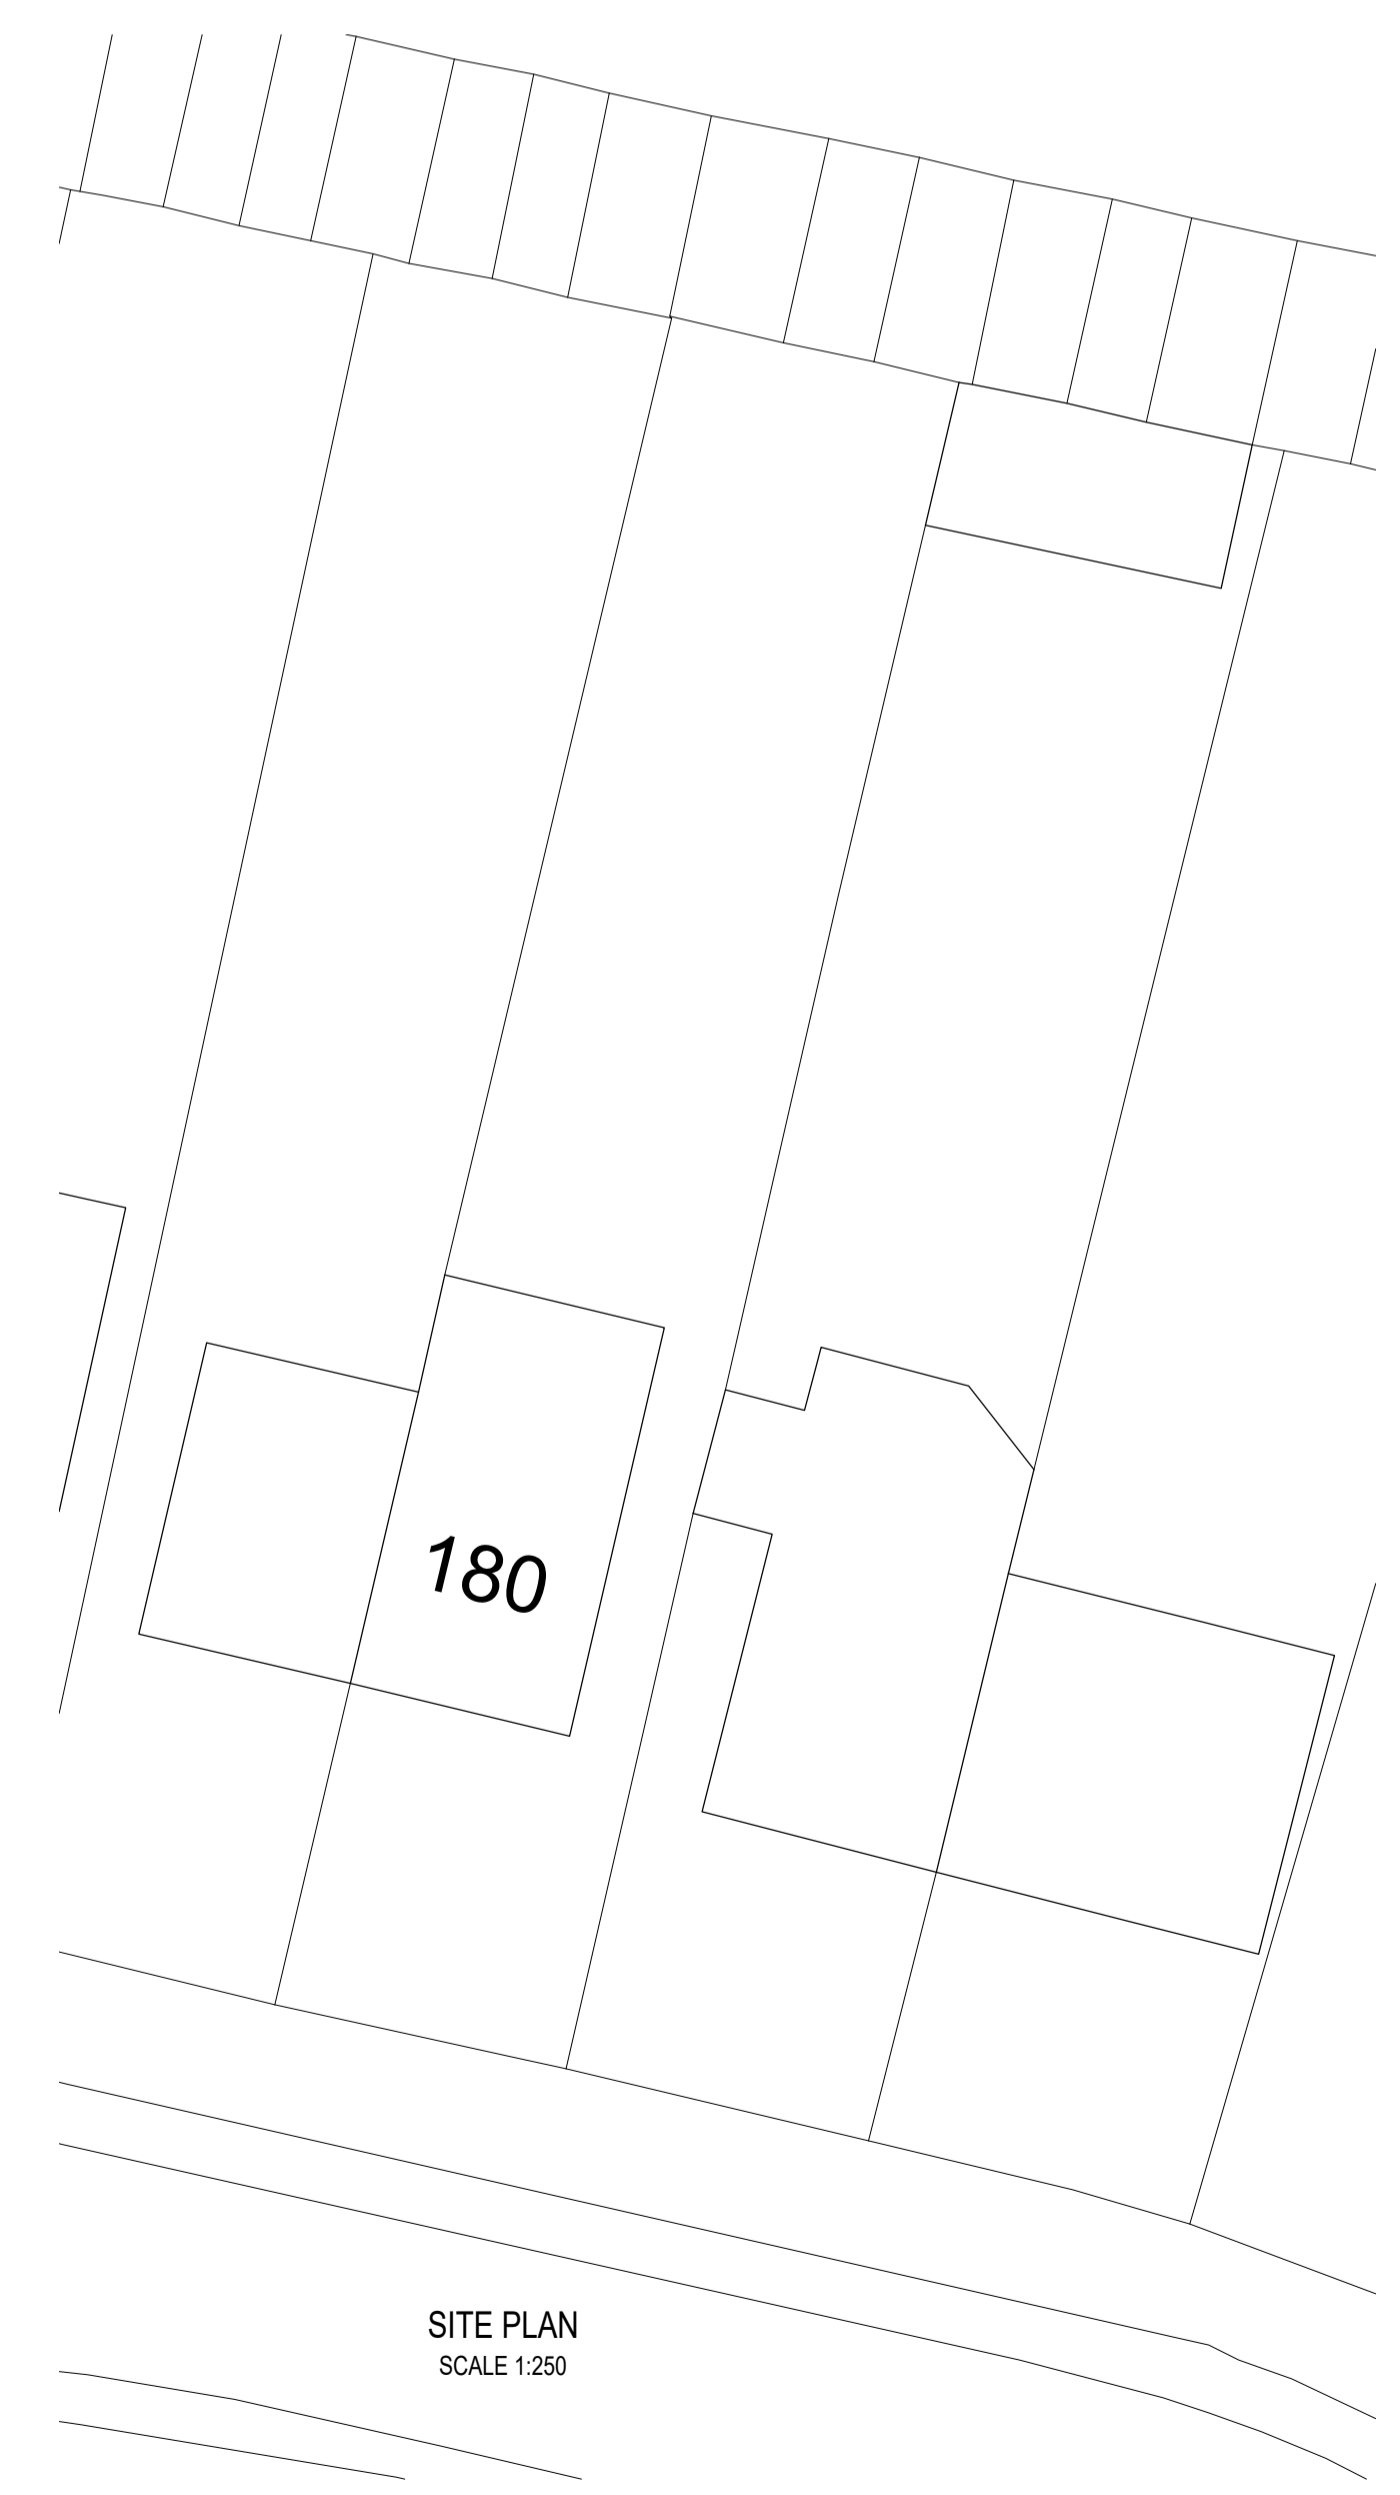

SITE PLAN
SCALE 1:250

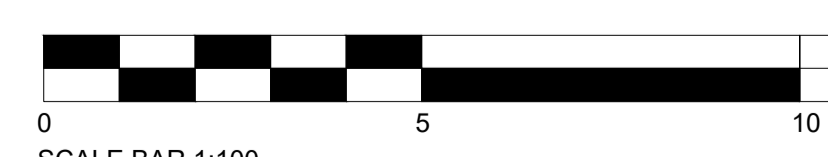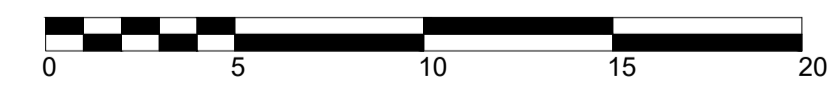

Rev.	Revision	Date
B	SITE PLAN AMENDED	31.08.21
A	DETAILS ADDED	10.08.21

Client
Mr. & Mrs. J. Houliston

Project
180 THE PARKWAY
IVER SLO ORG

Title
EXISTING ELEVATIONS
AND FLOOR LAYOUTS




Drawing Status:
PRELIMINARY FOR APPROVAL

Date: JULY 2021 Drawn by: PS
Scales: AS SHOWN AT A1 Checked:




MMP DESIGN

Tel: 01895 235611
Email: mail@mmpdesign.co.uk


Job No.	Org. No.	Rev.
5091	P01	B

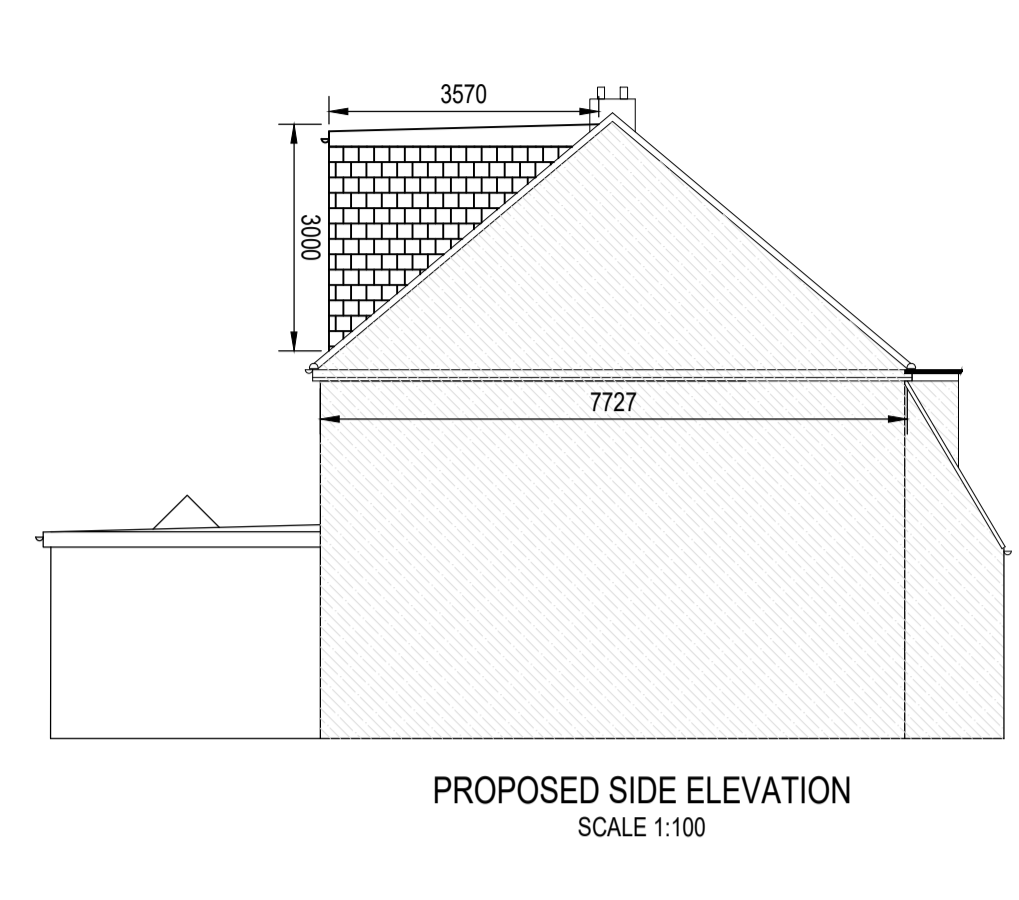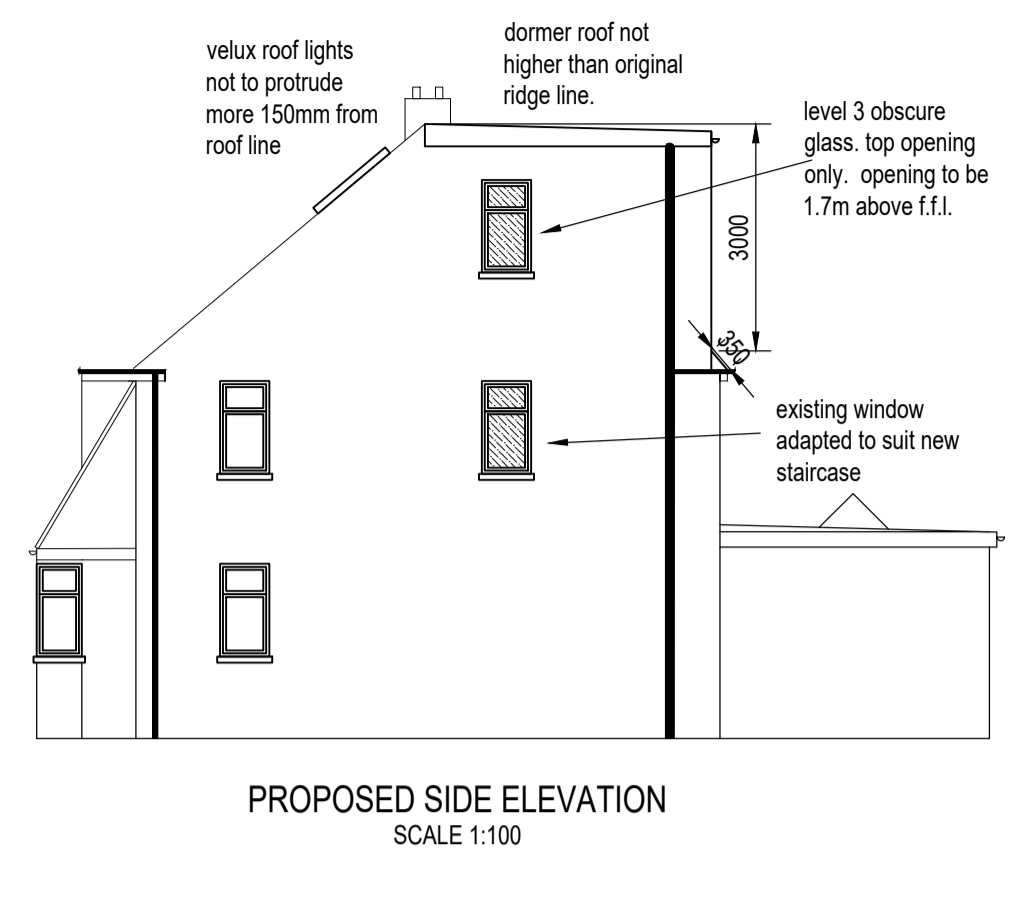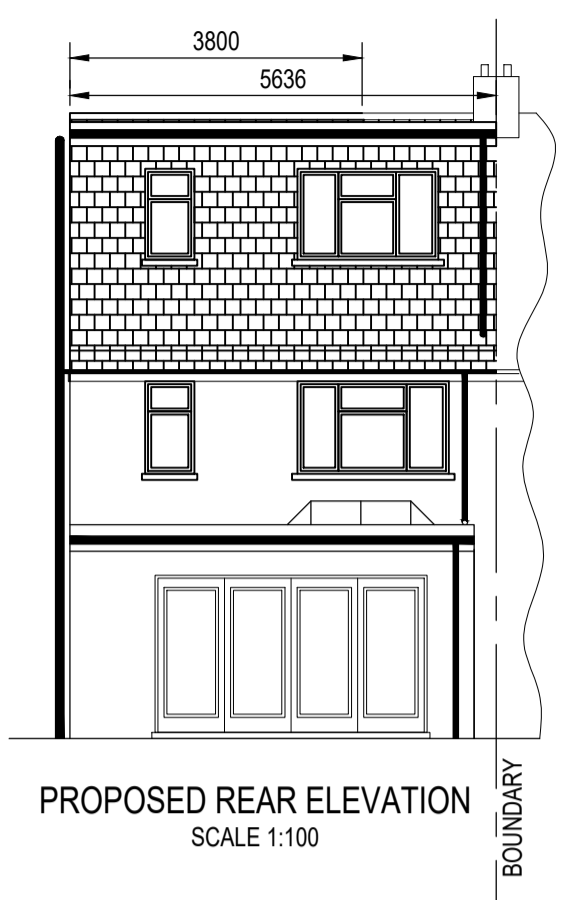



DORMER TO BE TILE HUNG
 DORMER FLAT ROOF SINGLE MEMBRANE COVERING
 GABLE END WALL TO MATCH EXISTING WHITE PAINTED RENDER FINISH
 WINDOWS TO MATCH EXISTING

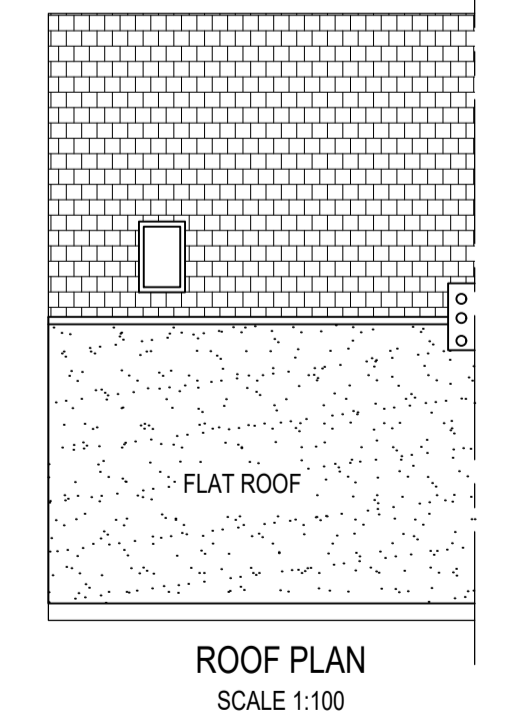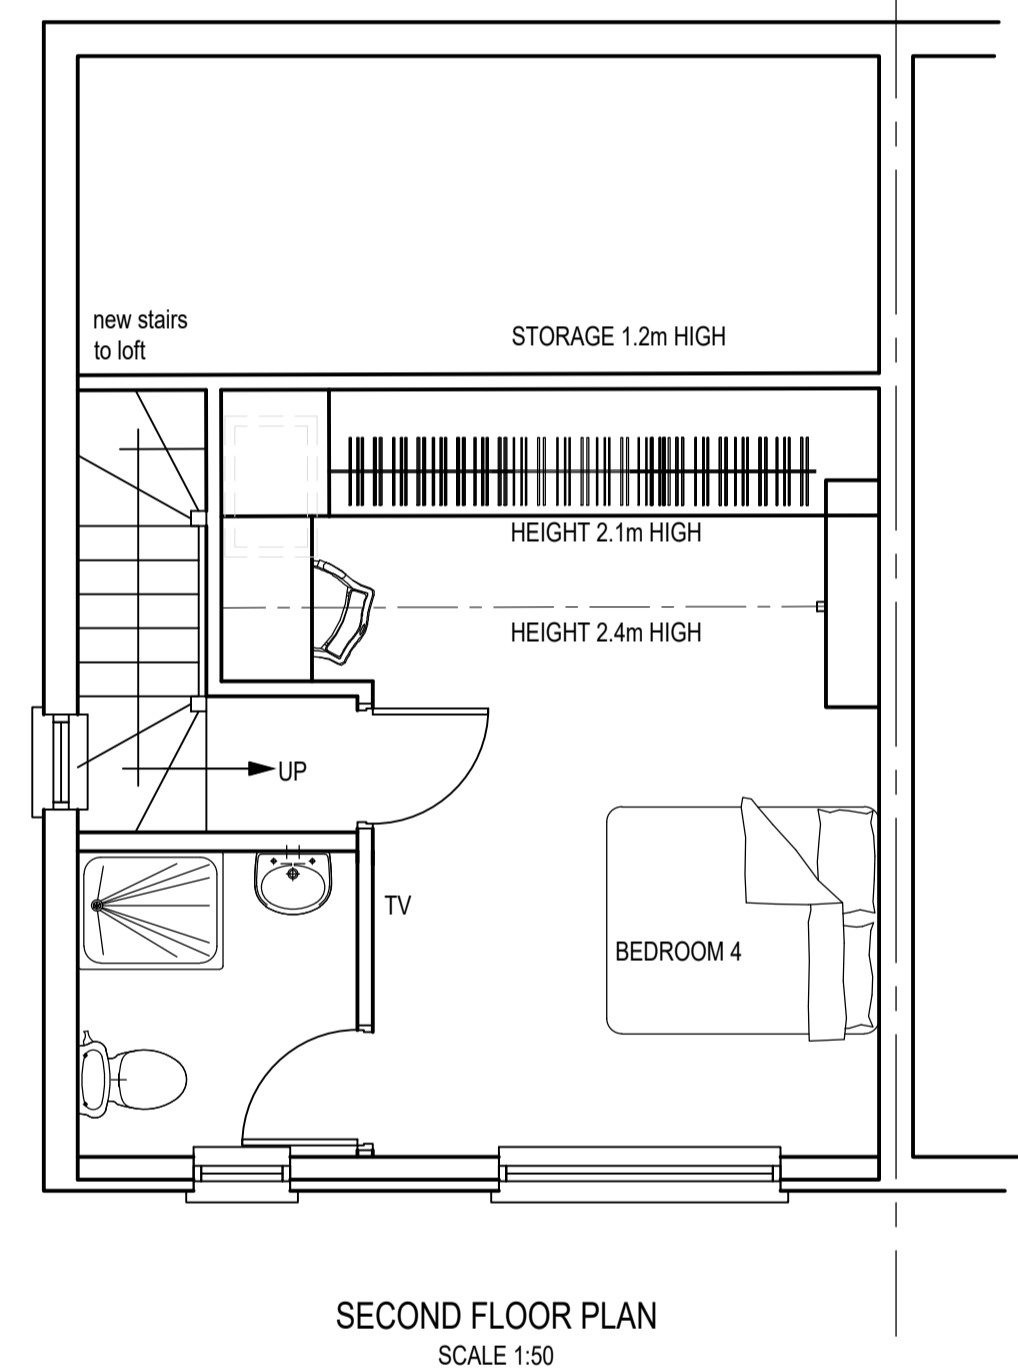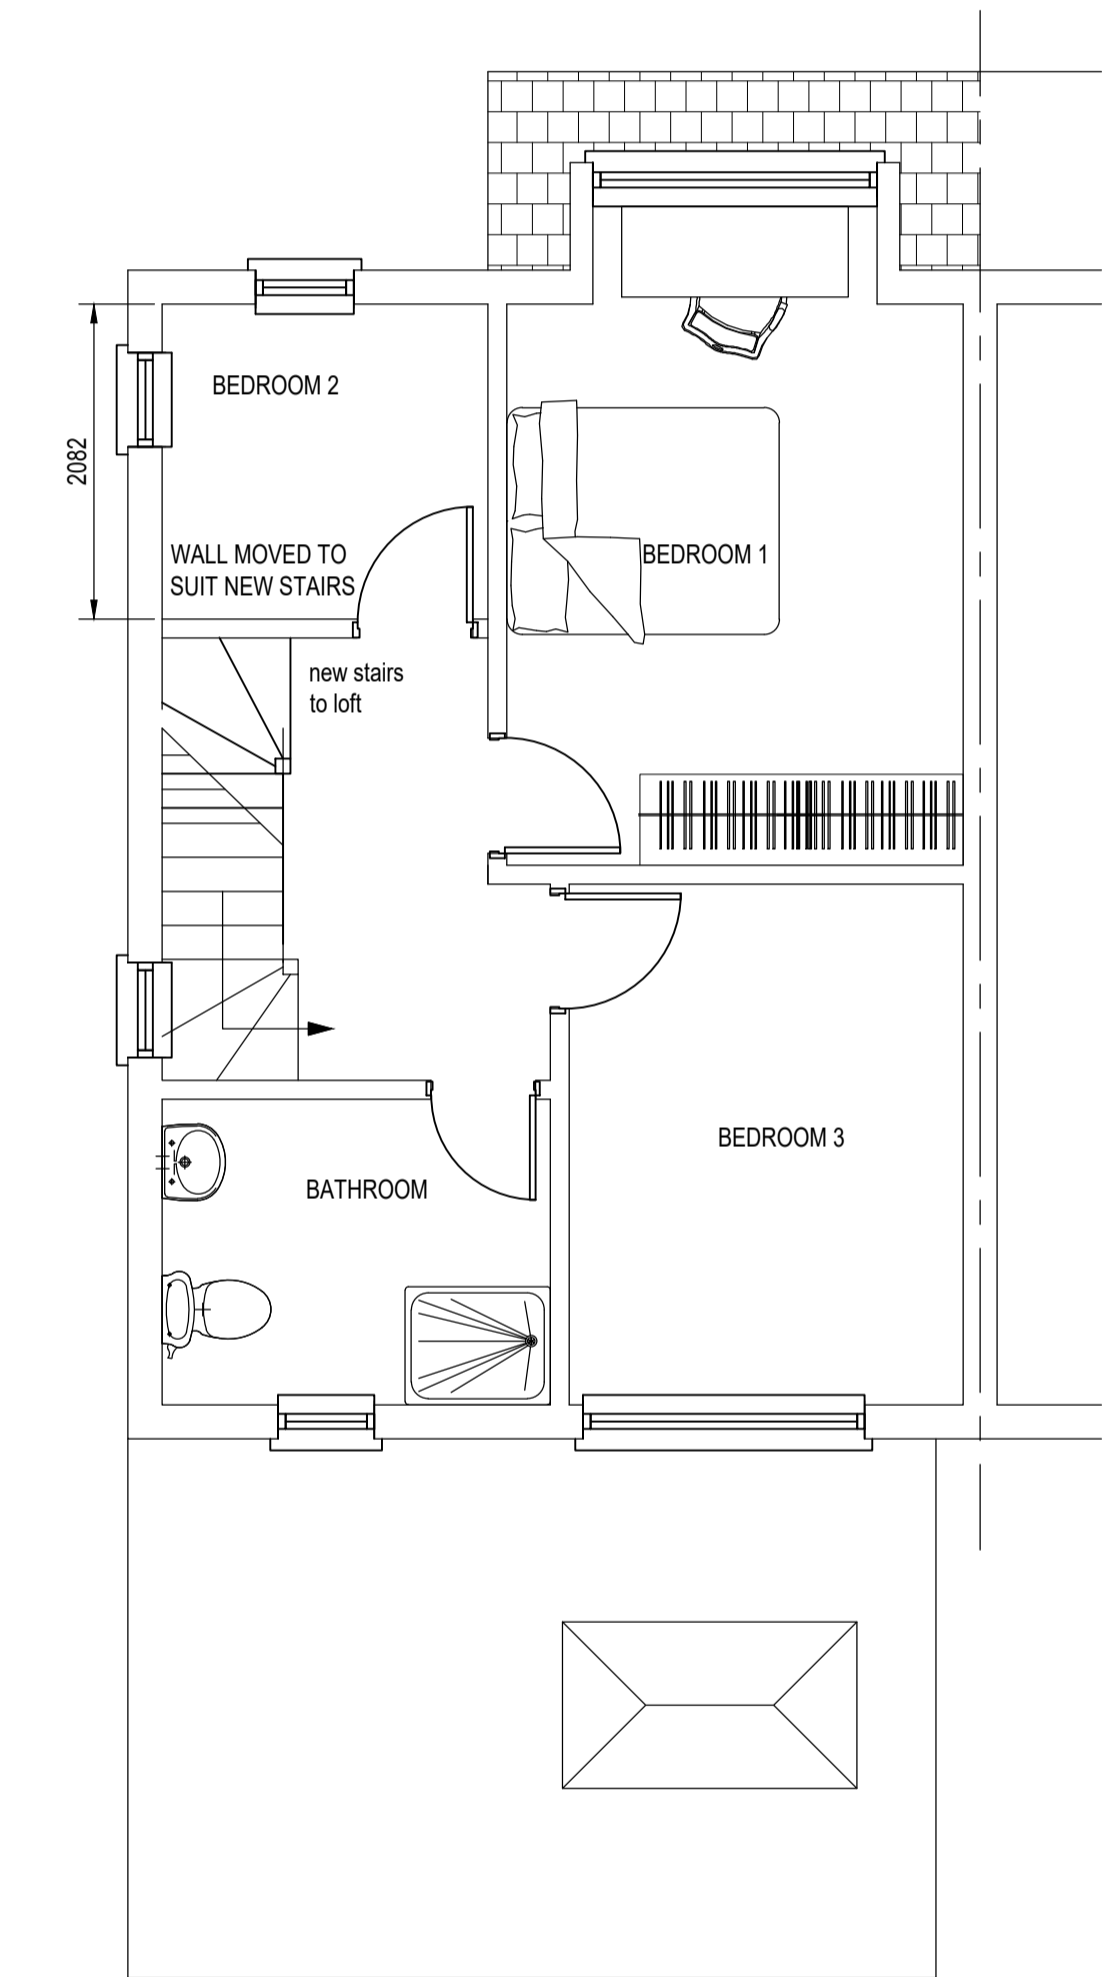

PROPOSED VOLUME OF DORMER EXTENSION
 HIP TO GABLE CONVERSION VOLUME
 $= \frac{1}{2} (7.73 \times 3.28) \times 3.8 = 16.06m^3$

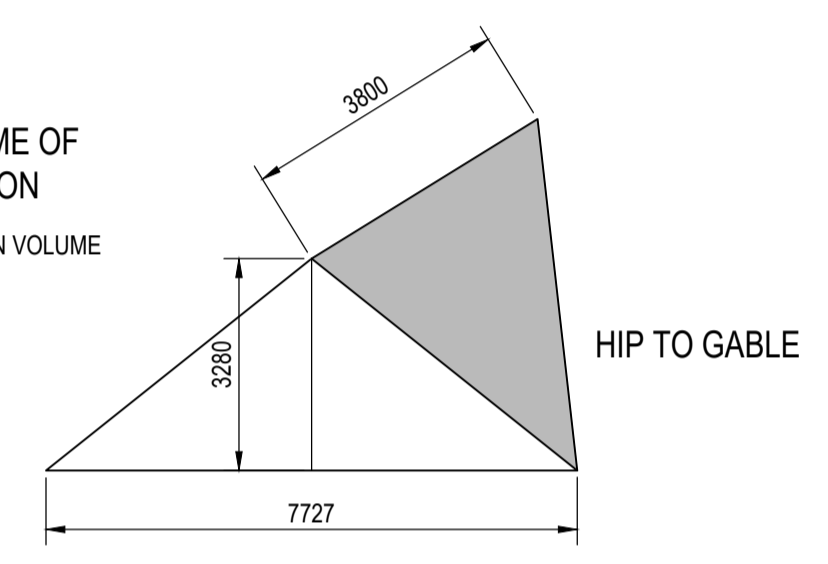

DORMER VOLUME
 $= 3.57 \times 3.00 \times 2.5 \times 5.636 = 30.80m^3$
 TOTAL VOLUME = 16.06 + 30.80 = 46.86m³ < 50m³

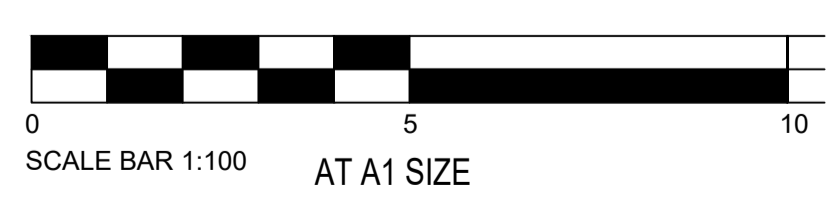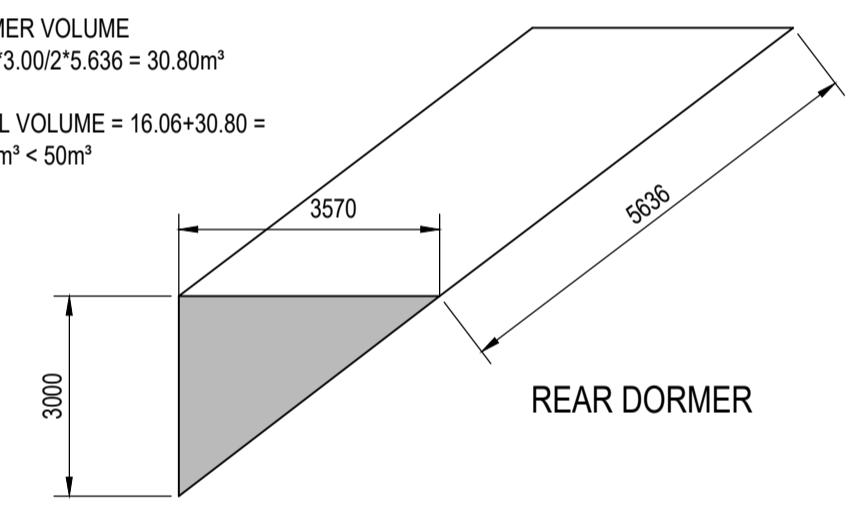

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Rev.	Revision	Date
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Client
 Mr. & Mrs. J. Houliston

Project
 180 THE PARKWAY
 IVER SLO ORG

Title
 LOFT CONVERSION
 PROPOSED LAYOUTS AND ELEVATIONS

Drawing Status:
 PRELIMINARY FOR APPROVAL

Date: AUGUST 2021 Drawn by: PS
 Scales: AS SHOWN AT A1 Checked:

MMP DESIGN

Tel: 01895 235611
 Email: mail@mmpdesign.co.uk

Job No.	Org. No.	Rev.
5091	P03	